

SITE: 235 BLOCKHOUSE BAY ROAD, AVONDALE

Comprised in: 381504 Total Area: 451M<sup>2</sup>

PROPOSED SUBDIVISION OF LOT 1 DP 395502

Client: Asha Dang Project No: 221123 Date: 28/NOV/2022

Drawing Number: 1/1 Scale: 1:150@A3

Drawn: HP


# H3 GROUP LTD

Land Development and Surveying hi.h3g@outlook.com Phone: 022 5586 333



Approved Resource Consent Plan

07/09/2023

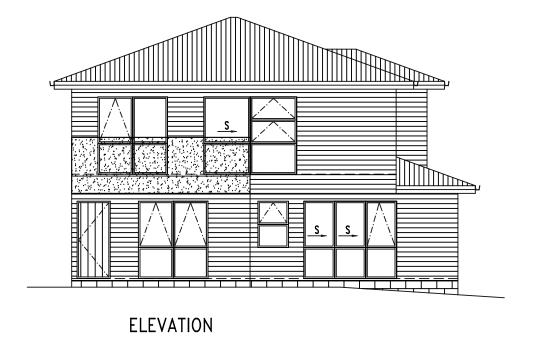

# ARCHITECTURAL DRAWINGS

DOCUMENT ENCLOSED	DWG NO.	DWG SIZE	SCALE	REV.
COVER SHEET	00	А3	NTS	00
EXISTING SITE PLAN	EX	A3	1:200	2
OVERALL SITE PLAN	1	А3	1:200	4
OUTLOOK SPACE	2	А3	1:100	4
OUTDOOR LIVING SPACE & HIRB	3	A3	1:100	4
LANDSCAPE PLAN & FENCES	4	А3	1:100	4
VEHICAL TRACKING PLANS	5	А3	1:100	4
EARTHWORK PLAN	6	A3	1:100	2
FLOOR PLANS	7	А3	1:100	5
ELEVATIONS	8	A3	1:100	5
EXISTING FLOOR PLAN	9	А3	1:100	0

# FOR RESOURCE CONSENT

R & S DESIGN
467 Richardson Road
Mt. Roskill, Auckland 1041
PH (09) 627 2160

Mt. Roskill, Auckland 1041 PH (09) 627 2160 MOB. 021 1587 422 EMAIL rs.design@xtra.co.nz JOB TITLE:

PROPOSED BUILDING AT 235 BLOCKHOUSE BAY ROAD AVONDALE, AUCKLAND FOR ASHA DANG

STATUS:	Resource Consent
JOB NO.:	01-21
ISSUED:	07/05/2023
RIVISION:	4

EX

REV:

Rev:-2


JOB NO.: DATE:

01-21

21/03/2023

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07/09/2023

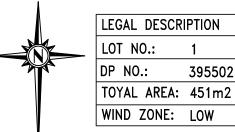


395502

AT 235 BLOCKHOUSE BAY ROAD

AVONDALE, AUCKLAND

FOR ASHA DANG

MIXED HOUSING URBAN ZONE SITE COVERAGE: 45% OF NETT SITE
IMPERMABLE SURFACE: 60% OF GROSS SITE LANDSCAPE AREA: 35% OF NETT SITE FRONT YARD LANDSCAPE: 50% OF 2.5m

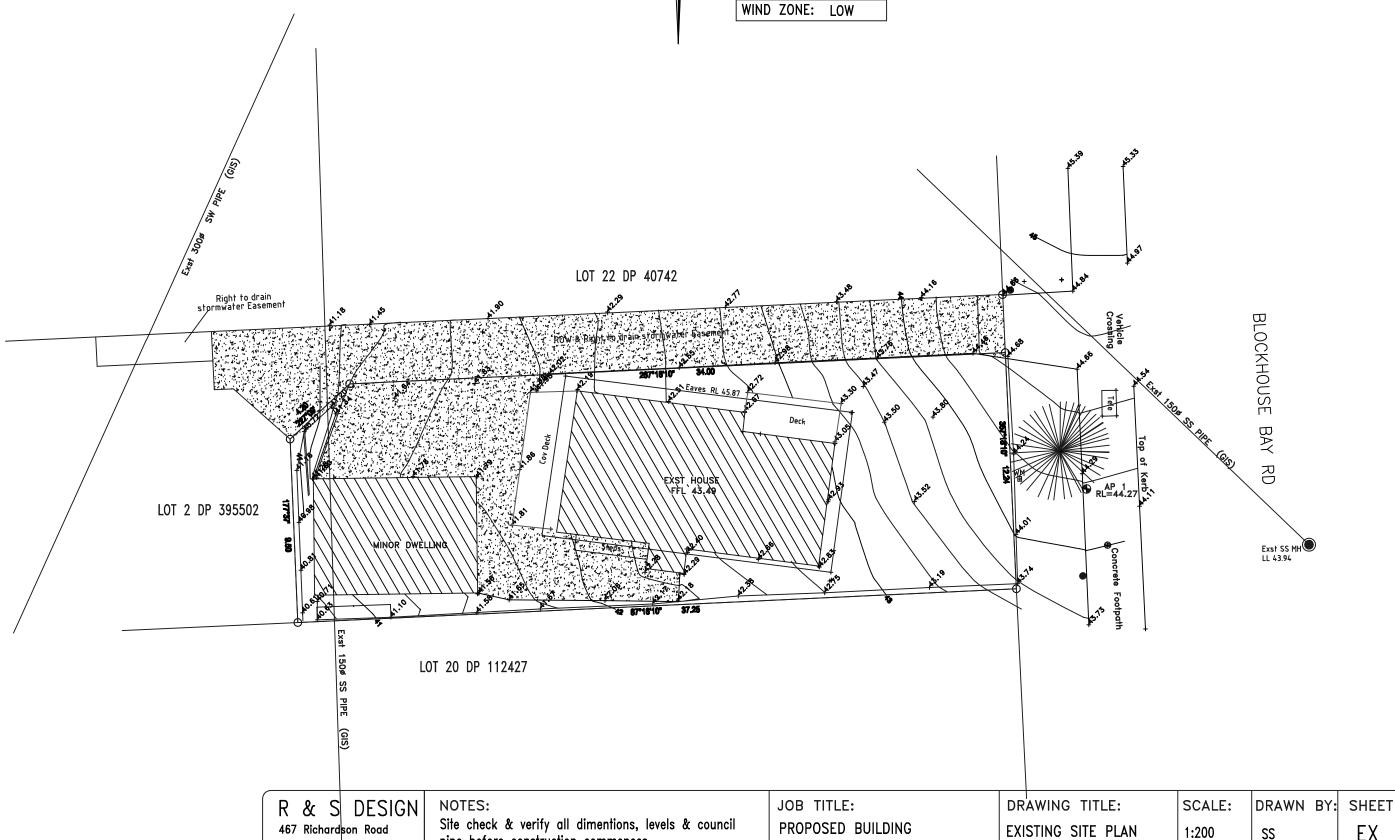

pipe before construction commences.

All works shall comply & be completed in accordance with the New Zealand Building Code.

Mt. Roskill, Auckland 1041

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Auckland Council

BUN60397004

Approved Resource Consent Plan

07/09/2023

MIXED HOUSING URBAN ZONE

SITE COVERAGE: 45% OF NETT SITE IMPERMABLE SURFACE: 60% OF GROSS SITE LANDSCAPE AREA: 35% OF NETT SITE FRONT YARD LANDSCAPE: 50% OF 2.5m

ROOF AREA

LEGAL DESCRIPTION

TOYAL AREA: 451m2

WIND ZONE: LOW

395502


LOT NO .:

DP NO.:

Existing Dwelling = 93m2 Proposed Dwelling = 88m2

PAVED AREA

= 3m2Paved Area Front = 46m2

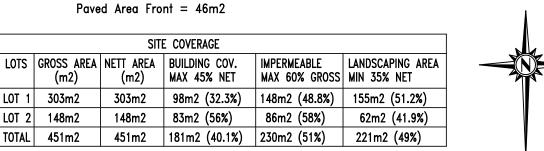

Existing Dwelling = 98m2

Proposed Dwelling = 83m2


= 3m2

Paved Area

LOT 1

LOT 2

TOTAL

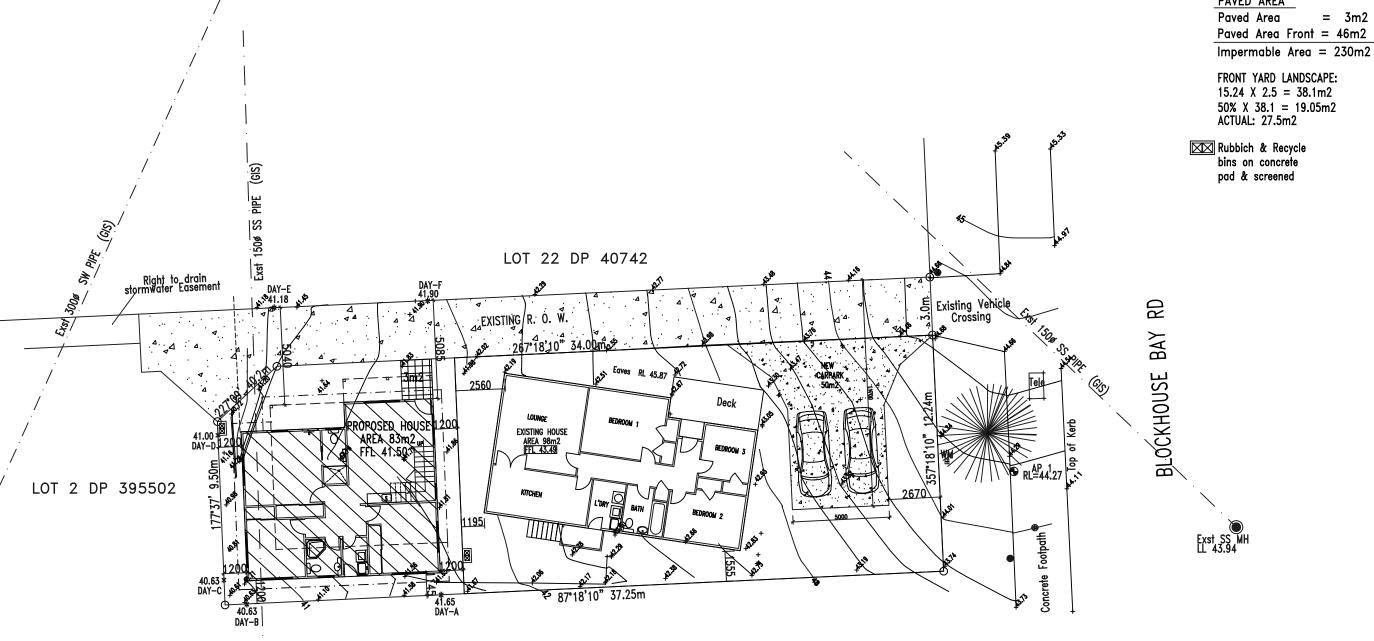

## R & S DESIGN

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#### **NOTES:**

Site check & verify all dimentions, levels & council pipe before construction commences.

JOB TITLE:
PROPOSED BUILDING
AT 235 BLOCKHOUSE BAY ROAD
AVONDALE, AUCKLAND
FOR ASHA DANG

DRAWING TITLE:	SCALE:	DRAWN BY:	SHEET
OVERALL SITE PLAN	1:200	SS	1
	JOB NO.:	DATE:	REV:
	01-21	07/05/2023	Rev:-4

Auckland Council
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#### BUN60397004


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07/09/2023



LEGAL DESCRIPTION
LOT NO.: 1
DP NO.: 395502

TOYAL AREA: 451m2
WIND ZONE: LOW

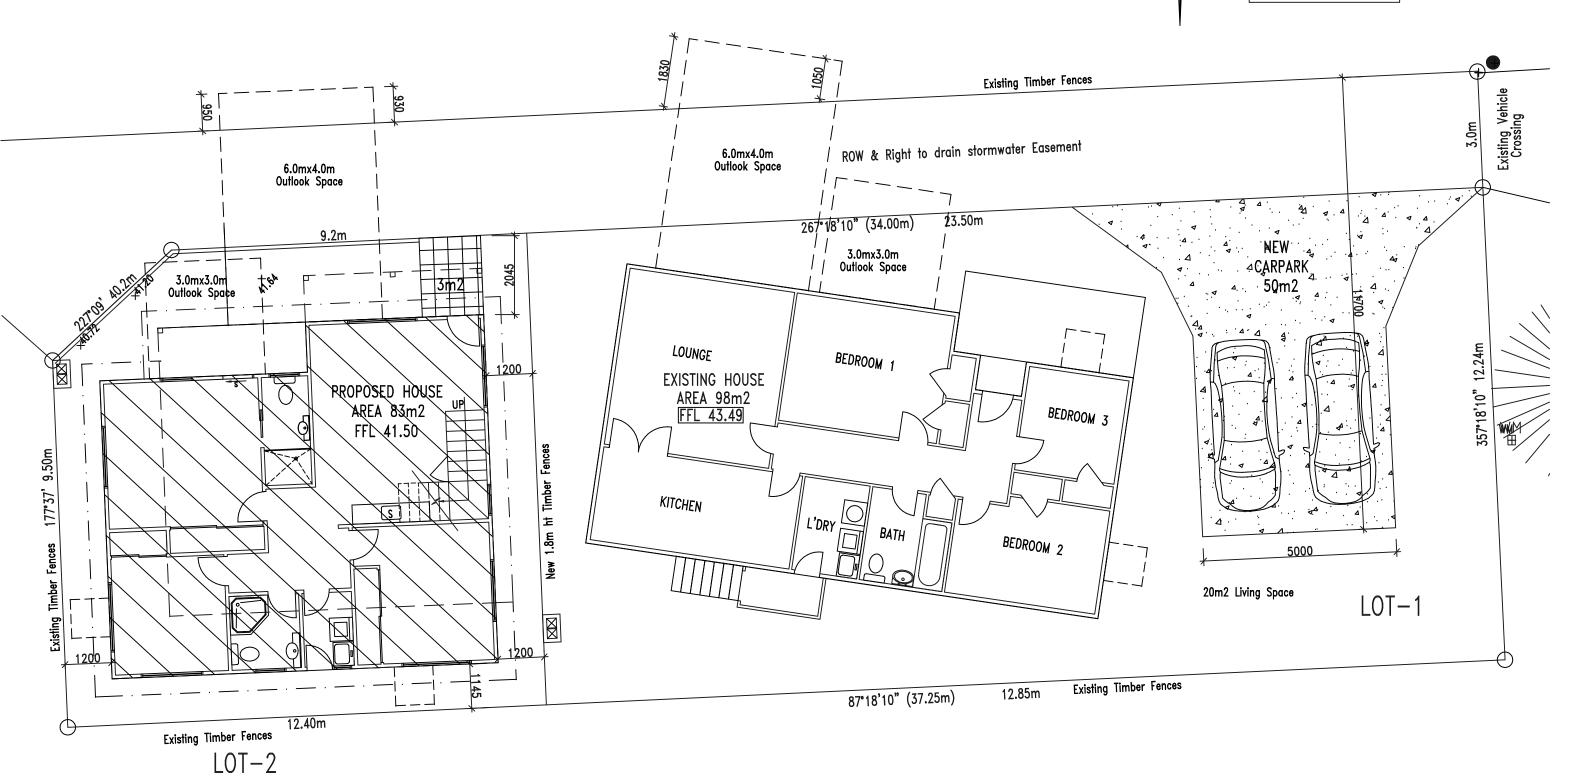

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PROPOSED BUILDING
AT 235 BLOCKHOUSE BAY ROAD
AVONDALE, AUCKLAND
FOR ASHA DANG

DRAWING TITLE:	SCALE:	DRAWN BY:	SHEET
OUTLOOK SPACE	1:100	SS	2
	JOB NO.:	DATE:	REV:
	01-21	03/08/2023	Rev:-5



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07/09/2023




LEGAL DESCRIPTION

LOT NO.: 1

DP NO.: 395502

TOYAL AREA: 451m2

WIND ZONE: LOW

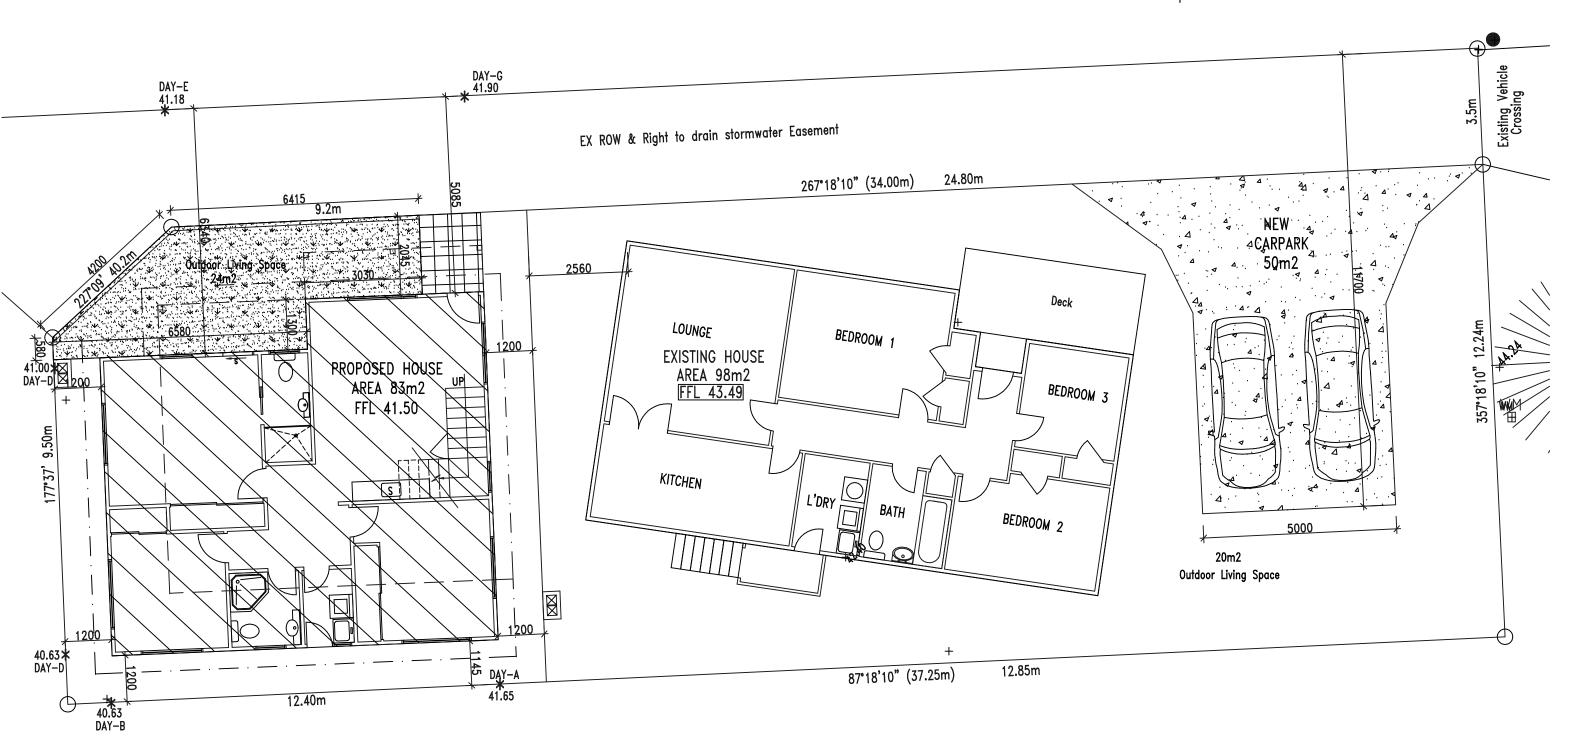

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467 Richardson Road Mt. Roskill, Auckland 1041 PH (09) 627 2160 MOB. 021 1587 422 EMAIL rs.design@xtra.co.nz

#### NOTES:


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JOB TITLE:	
PROPOSED BUILDING	
AT 235 BLOCKHOUSE BAY	ROAD
AVONDALE, AUCKLAND	
FOR ASHA DANG	

DRAWING TITLE:	SCALE:	DRAWN BY:	SHEET
OUTDOOR LIVING SPACE	1:100	SS	3
HIRB	JOB NO.:	DATE:	REV:
	01-21	03/08/2023	Rev:-5



LEGAL DESCRIPTION
LOT NO.: 1
DP NO.: 395502
TOYAL AREA: 451m2
WIND ZONE: LOW

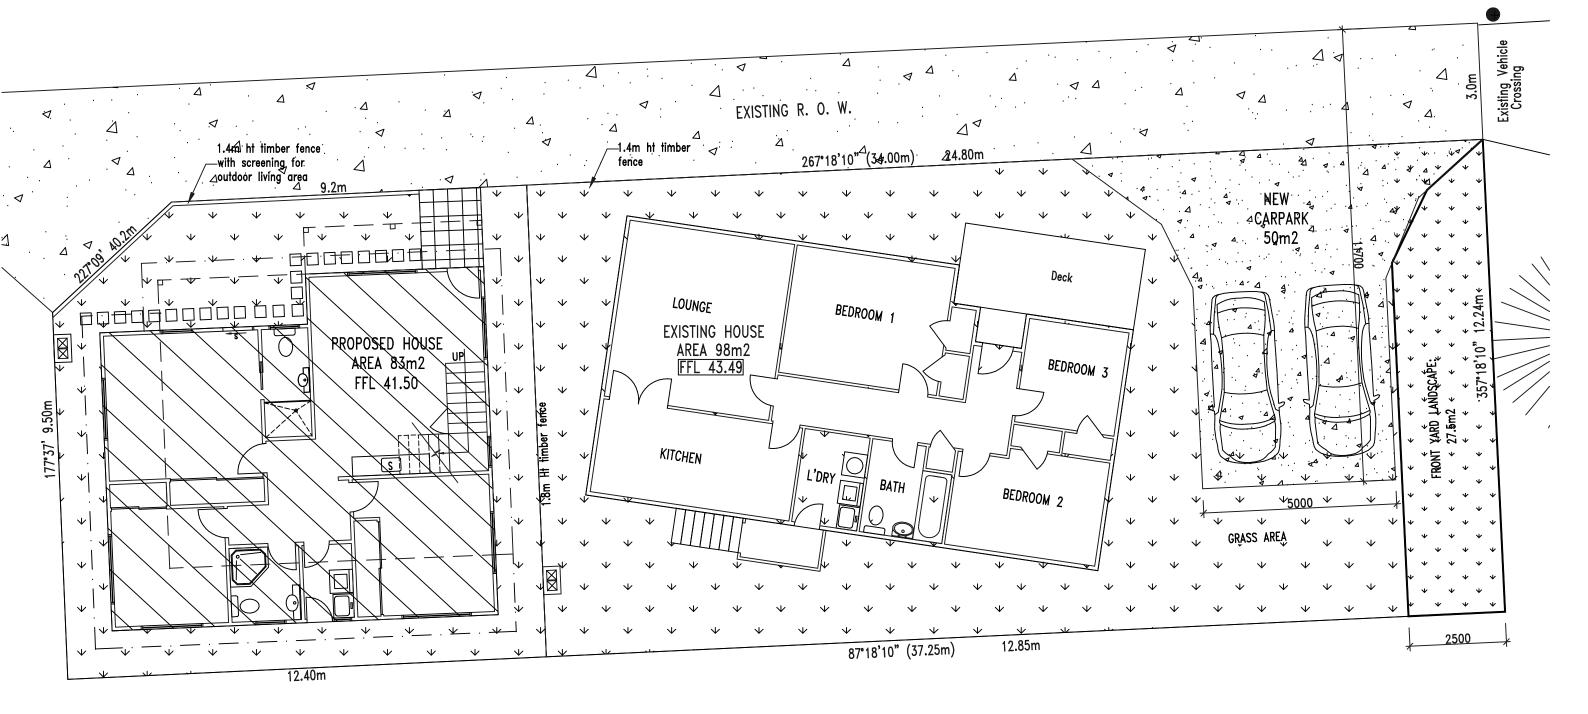

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467 Richardson Road Mt. Roskill, Auckland 1041 PH (09) 627 2160 MOB. 021 1587 422 EMAIL rs.design@xtra.co.nz NOTES:

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JOB TITLE:
PROPOSED BUILDING
AT 235 BLOCKHOUSE BAY ROAD
AVONDALE, AUCKLAND
FOR ASHA DANG

DRAWING TITLE: LANDSCAPE PLAN & FENCES 

 SCALE:
 DRAWN BY:
 SHEET

 1:100
 SS
 4

 JOB NO.:
 DATE:
 REV:


 01-21
 07/05/2023
 Rev:-4


# Auckland Council Prawfeer Trans Makazar

BUN60397004

Approved Resource Consent Plan

07/09/2023

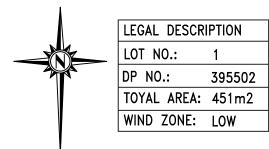

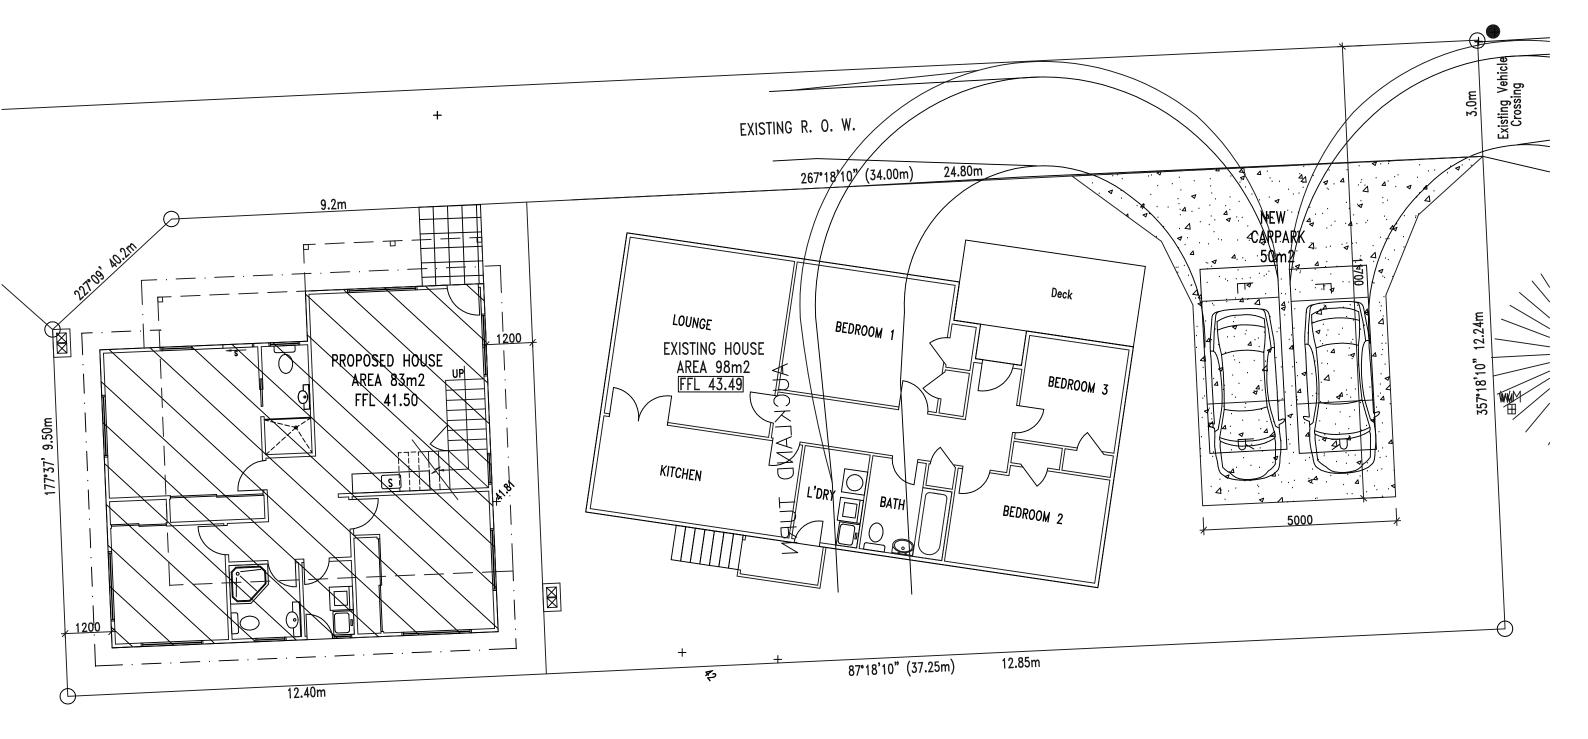

R	&	S	DESIGN


467 Richardson Road
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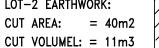
JOB TITLE:
PROPOSED BUILDING
AT 235 BLOCKHOUSE BAY ROAD
AVONDALE, AUCKLAND
FOR ASHA DANG

DRAWING TITLE:	SCALE:	DRAWN BY:	SHEET
VEHICAL TRACKING PLAN	1:100	SS	5
	JOB NO.:	DATE:	REV:
	01-21	07/05/2023	Rev:-3







LOT-2 EARTHWORK: CUT AREA:

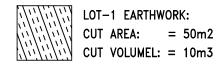

LOT-2 EARTHWORK: FILL AREA:

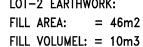

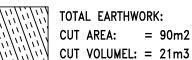




TOTAL EARTHWORK: FILL AREA: = 46m2FILL VOLUMEL: = 10m3



LEGAL DESCRIPTION LOT NO.: DP NO.: 395502 TOYAL AREA: 451m2 WIND ZONE: LOW

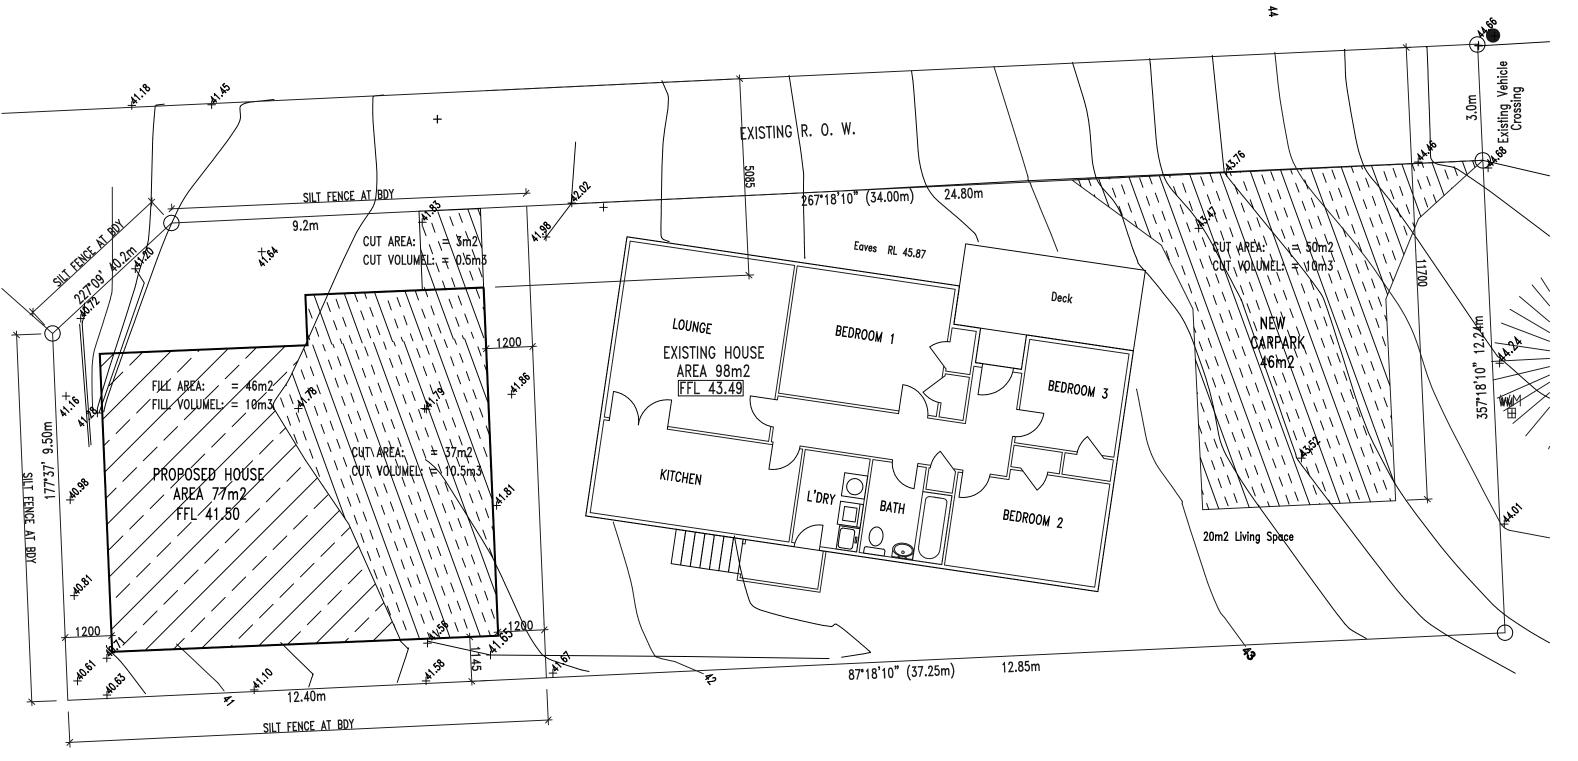

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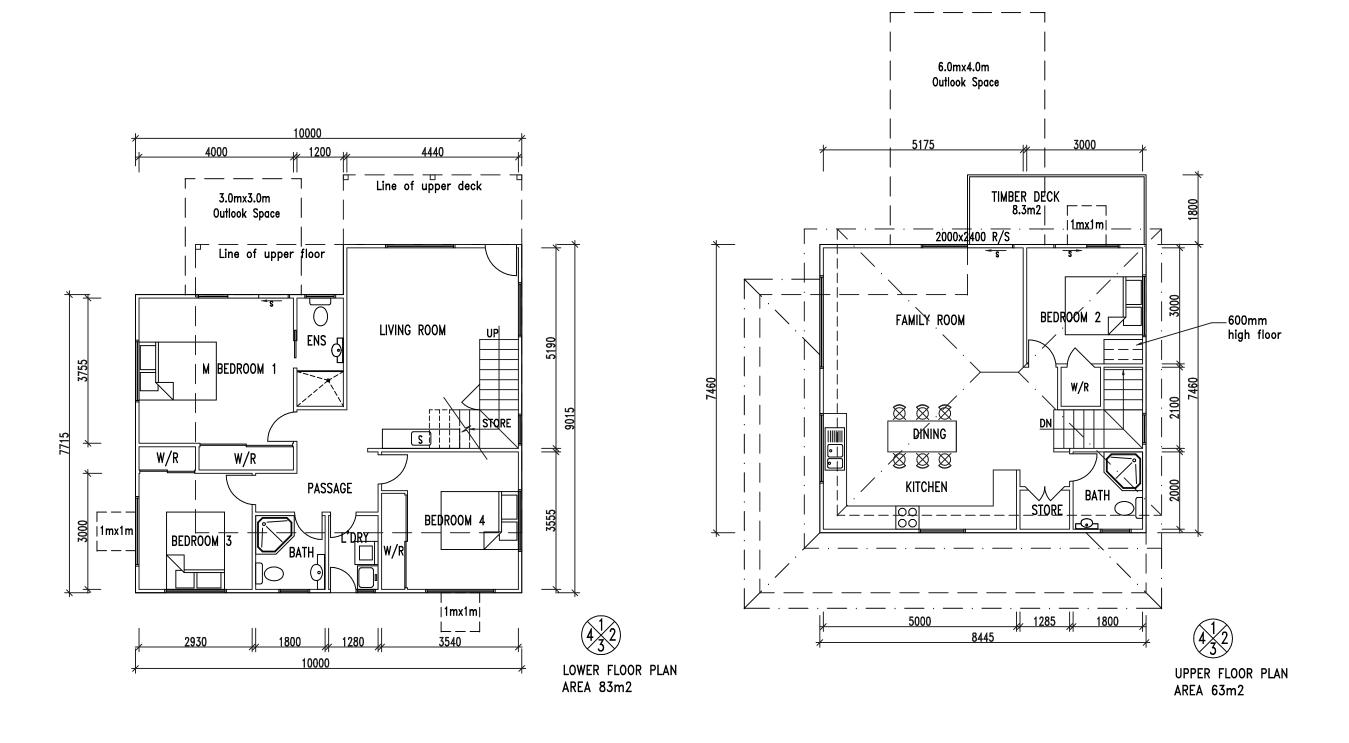
All works shall comply & be completed in accordance with the New Zealand Building Code.

#### JOB TITLE: PROPOSED BUILDING AT 235 BLOCKHOUSE BAY ROAD AVONDALE, AUCKLAND FOR ASHA DANG

DRAWING TITLE:	SCALE:	DRAWN BY:	SHEET
EARTHWORK PLAN	1:100	SS	6
	JOB NO.:	DATE:	REV:
	01-21	07/05/2023	Rev:-3

Approved Resource Consent Plan

07/09/2023



## R & S DESIGN


467 Richardson Road Mt. Roskill, Auckland 1041 PH (09) 627 2160 MOB. 021 1587 422 EMAIL rs.design@xtra.co.nz


#### NOTES:


Site check & verify all dimentions, levels & council pipe before construction commences.


JOB TITLE:
PROPOSED BUILDING
AT 235 BLOCKHOUSE BAY ROAD
AVONDALE, AUCKLAND
FOR ASHA DANG

DRAWING TITLE:	SCALE:	DRAWN BY:	SHEET
FLOOR PLANS	1:100	SS	7
	JOB NO.:	DATE:	REV:
	01-21	03/08/2023	Rev:-6

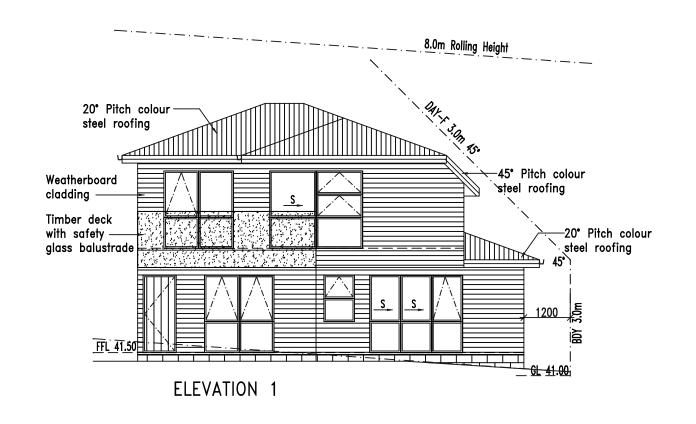

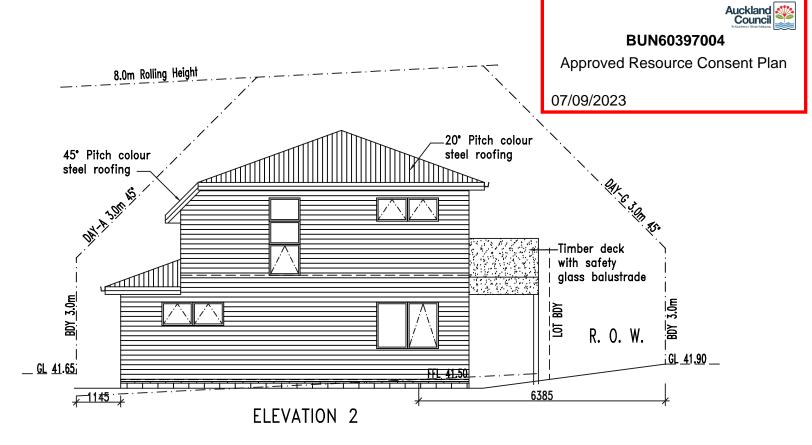

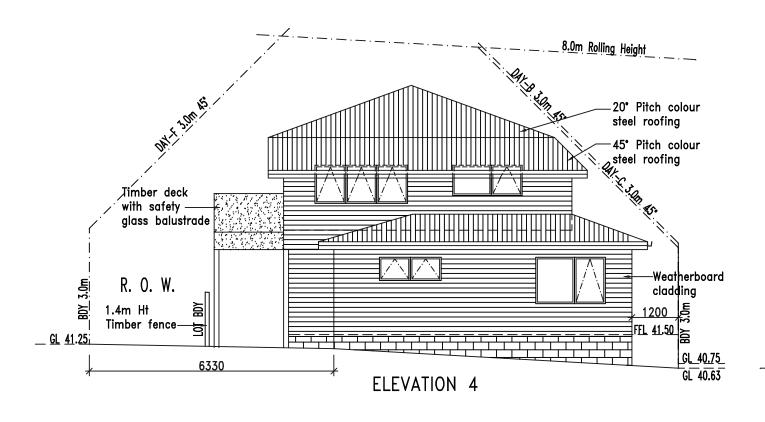

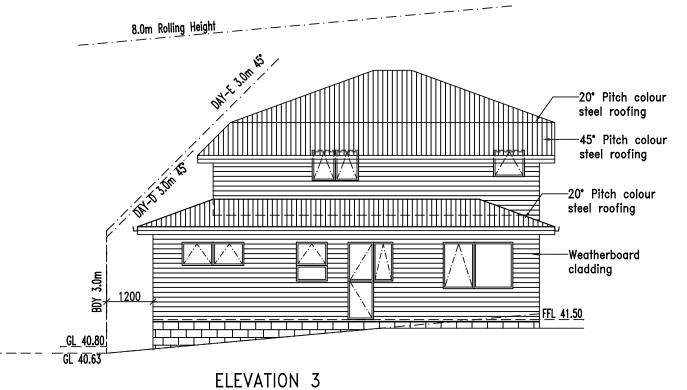

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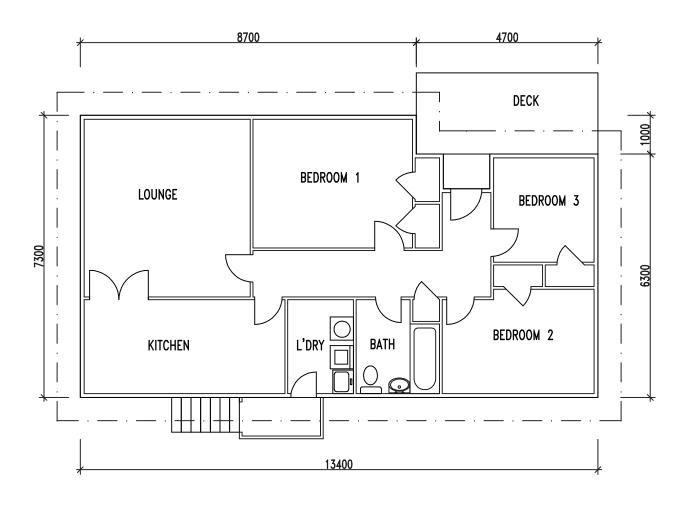
PROPOSED BUILDING AT 235 BLOCKHOUSE BAY ROAD AVONDALE, AUCKLAND FOR ASHA DANG

DRAWING '	TITLE:
ELEVATIONS	

SCALE:	DRAWN BY:	SHEET
1:100	SS	8
JOB NO.:	DATE:	REV:
01-21	03/08/2023	Rev:-6



07/09/2023



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PROPOSED BUILDING AT 235 BLOCKHOUSE BAY ROAD AVONDALE, AUCKLAND FOR ASHA DANG
AT 235 BLOCKHOUSE BAY ROAD
AVONDALE, AUCKLAND
FOR ASHA DANG

DRAWING TITLE:	SCALE:	DRAWN BY:	SHEET
EXISTING FLOOR PLAN	1:100	SS	9
	JOB NO.:	DATE:	REV:
	01-21	22/09/2021	Rev:-0

# ENGINEERING PLAN APPROVAL DRAWINGS

Auckland Council State of the S

Approved Resource Consent Plan

07/09/2023

# PROPOSED NEW DWELLING 235 BLOCKHOUSE BAY ROAD AVONDALE AUCKLAND

CLIENT: ASHA DANG

**JOB #:** 

**R&SDESIGNS** 

ARCHITECTURAL JOB#: 01-21 DATE: -

**DRAWING:** 

SURVEYOR: -

JOB#: - DATE: -

CCTV:

JOB#: - DATE: -



#### **GENERAL NOTES:**

#### 1.1. PRIOR TO CONSTRUCTION:

- 1.2. CONTRACTOR TO CONFIRM LOCATION OF ALL SERVICES ON SITE PRIOR TO CONSTRUCTION. NOTIFY AND DISCUSS ANY DISCREPANCIES WITH DESIGN AND/OR SITE FINGINFER.
- 1.3. THE CONTRACTOR SHALL CHECK ALL DIMENSIONS ON SITE AND CONFIRM ALL DETAILS ARE CONSISTENT BETWEEN ARCHITECTURAL AND ENGINEERING DRAWINGS. ANY DISCREPANCIES ARE TO BE NOTIFIED AND DISCUSSED WITH ARCHITECT AND DESIGN ENGINEER IMMEDIATELY, AND PRIOR TO COMMENCEMENT OF WORK.
- 1.4. THE CONTRACTOR SHALL SUBMIT CONSTRUCTION METHODOLOGY TO ENGINEER FOR REVIEW. DISCUSSION AND APPROVAL.

#### **WASTE WATER NOTES:**

- 1. ALL WORKMANSHIP AND MATERIALS SHALL COMPLY WITH WATERCARE AND AUCKLAND COUNCIL SPECIFICATION AND STANDARD DETAILS.
- 2. ALL MEASUREMENTS AND DIMENSIONS ARE IN METER, UNLESS NOTED OTHERWISE.
- ALL WORK ON EXISTING STORMWATER AND SANITARY SEWER LINES TO CARRIED OUT BY A REGISTERED CONTRACTOR.
- 4. ALL LEVELS ARE IN TERMS OF LANDS AND SURVEY DATUM. ALL CO-ORINATES ARE IN TERMS OF GEODETIC DATUM 2000.
- CERTIFIED ENGINEER/SURVEYOR TO ENSURE PIPES ARE LAID TO THE CORRECT GRADE AND DEPTH.
- ALL PROPOSED PUBLIC SANITARY SEWER LINES ARE TO BE uPVC SN16, UNLESS NOTED OTHERWISE.
- 7. ALL MANHOLES ARE TO BE INSTALLED WITH STANDARD LIDS AND COVERS BOLTED WITH FLANGE BASE, UNLESS SHOWN OTHERWISE.
- 8. REFER TO STANDARD DRAWINGS FOR DETAILS.
- 9. HARDFILL BACKFILL TO BE GAP 65.
- 10. ALL PIPES ARE TO LAID IN APPROVED GRANULAR BEDDING. PIPES WITH A GRADE OF 10.0% OR MORE ARE TO BE LAID IN (5MPa) SCORIA CONCTRETE BEDDING.
- 11. POSITION AND LEVEL (OR EXISTENCE) OF THE PUBLIC UTILITIES SERVICE, WATER MAIN AND OTHER SERVICE IS SUBJECT TO VERIFICATION ONSITE BY THE OWNER AND/OR THEIR CONTRACTOR.
- 12. THE CONTRACTOR TO LOCATE ALL THE UNDERGROUND SERVICES (POWER, TELECOM, GAS & WATER) ON SITE PRIOR TO CONSTRUCTION AND IF POSSIBLE LOCATED BY THE RELEVANT AUTHORITIES. THE LOCATION SHOWN IS JUST FOR INFORMATION ONLY.
- 13. THE CONTRACTOR TO APPLY FOR THE CAR & TRAFFIC MANAGEMENT PLANS FOR THE CONSTRUCTION OF THE SERVICE ON THE CARRIAGEWAY AND BERM.
- 14. ALL THE UTILITY SERVICES IN COMMON ACCESSWAY TO BE IN RELEVANT DUCTS.
- 15. EXISTING SERVICES TO THE EXISTING DWELLING TO BE REDIRECTED IF REQUIRED TO THE RELEVANT BOUNDARIES.
- 16. EXISTING DRAINAGE TO BE LOCATED BEFORE ANY FOUNDATION WORK CARRIED OUT. IF REQUIRED, OR CRITICAL TO BRIDGING.
- 17. SURVEY DONE BY OTHERS, AA & CO INTERNATIONAL LTD DOES NOT TAKE ANY RESPONSIBILITIES OF LEVELS.
- 18. ALL DIMENSIONS AND MEASUREMENTS ARE IN METER, UNLESS NOTED OTHERWISE.
  19. ALL MEASUREMENTS ARE APPROXIMATE ONLY AND ARE SUBJECT TO FINAL SURVEY
- 20. ALL LEVELS ARE TO BE VERIFIED BY CONTRACTORS ONSITE.


#### **STORM WATER NOTES:**

- 1. ALL WORKMANSHIP AND MATERIALS SHALL COMPLY WITH AUCKLAND COUNCIL SPECIFICATION AND STANDARD DETAILS.
- 2. ALL WORK ON EXISTING STORMWATER AND SANITARY SEWER LINES TO CARRIED OUT BY A REGISTERED CONTRACTOR.
- 3. ALL LEVELS ARE IN TERMS OF LANDS AND SURVEY DATUM. ALL CO-ORINATES ARE IN TERMS OF GEODETIC DATUM 2000.
- 4. ALL PROPOSED STORMWATER CONNECTIONS ARE TO BE 100mmØ uPVC. ALL CONNECTIONS ARE TO TERMINATE WITHIN 1.0m, UNLESS OTHERWISE NOTED AT THE NEW LOT BOUNDARY.
- 5. ALL MANHOLES ARE TO BE 1050mm WITH STANDARD LIDS AND COVERS, UNLESS SHOWN OTHERWISE.
- BEDDING TYPICALLY GAP 14 OR GAP 20. REFER TO CODE OF PRACTICE FOR WORKING IN THE ROAD BY AUCKLAND TRANSPORT.
- 7. REFER TO STANDARD DRAWINGS FOR DETAILS.
- 8. HARDFILL BACKFILL TO BE GAP 65.
- ALL PIPES ARE TO LAID IN APPROVED GRANULAR BEDDING. PIPES WITH A GRADE OF 10.0% OR MORE ARE TO BE LAID IN (5MPa) SCORIA CONCRETE BEDDING.
- 10. THE CONTRACTOR TO LOCATE ALL THE UNDERGROUND SERVICES (POWER, TELECOM, GAS & WATER) ON SITE PRIOR TO CONSTRUCTION AND IF POSSIBLE LOCATED BY THE RELEVANT AUTHORITIES. THE LOCATION SHOWN IS JUST FOR INFORMATION ONLY
- 11. ALL THE UTILITY SERVICES IN COMMON ACCESSWAY TO BE IN RELEVANT DUCTS.
- 12. THE CONTRACTOR TO APPLY FOR THE CAR & TRAFFIC MANAGEMENT PLANS FOR THE CONSTRUCTION OF THE SERVICE ON THE CARRIAGEWAY AND BERM.
- 13. EXISTING SERVICES TO THE EXISTING DWELLING TO BE REDIRECTED IF REQUIRED TO THE RELEVANT BOUNDARIES.
- 14.EXISTING DRAINAGE TO BE LOCATED BEFORE ANY FOUNDATION WORK CARRIED OUT. IF REQUIRED, OR CRITICAL TO BRIDGING.
- 15. SURVEY DONE BY OTHERS, AA & CO INTERNATIONAL LTD DOES NOT TAKE ANY RESPONSIBILITIES OF LEVELS.
- 16. ALL DIMENSIONS AND MEASUREMENTS ARE IN METER, UNLESS NOTED OTHERWISE.
- 17. ALL MEASUREMENTS ARE APPROXIMATE ONLY AND ARE SUBJECT TO FINAL SURVEY.
- 18. PROVIDE CONCRETE CAPPING WHERE PIPE COVER IS LESS THAN 600mm

#### **DRIVEWAY NOTES:**

- ALL PRIVATE DRIVEWAY WORK TO COMPLY WITH AUCKLAND TRANSPORT STANDARDS.
- ALL WORK ON EXISTING STORMWATER AND SANITARY SEWER LINES TO BE CARRIED OUT BY A REGISTERED CONTRACTOR.
- 3. TOPOGRAPHIC DATA ARE OBTAINED FROM SURVEYOR.
- 4. ALL LEVELS ARE IN TERMS OF LANDS AND SURVEY DATUM. ALL CO-ORINATES ARE IN TERMS OF GEODETIC DATUM 2000.
- 5. REFER TO STANDARD DRAWINGS FOR DETAILS.
- SUBGRADE TO HAVE A MINIMUM CBR OF 7 AS PER AUCKLAND TRANSPORT ENGINEERING STANDARDS
- 7. BEDDING TYPICALLY 50mm MINNIMUM COMPACTED GAP 20 AS PER AUCKLAND TRANSPORT ENGINEERING STANDARDS
- 8. BASECOURSE TO BE 150mm THICK CONCRETE AS PER AUCKLAND TRANSPORT ENGINEERING STANDARDS
- ALL CONCRETE TO BE 20MPa AND CONTRUCTED IN ACCORDANCE WITH NZS 3109 WITH A BROOM FINISH. SAWCUT EXPANSION JOINTS AT 4m CENTRES.
- 10.THE CONTRACTOR TO LOCATE ALL THE UNDERGROUND SERVICES (POWER, TELECOM, GAS & WATER) ON SITE PRIOR TO CONSTRUCTION AND IF POSSIBLE LOCATED BY THE RELEVANT AUTHORITIES. THE LOCATION SHOWN IS JUST FOR INFORMATION ONLY.
- 11. THE CONTRACTOR TO APPLY FOR THE CAR & TRAFFIC MANAGEMENT PLANS FOR THE CONSTRUCTION OF THE SERVICE ON THE CARRIAGEWAY AND BERM.
- 12. ALL THE UTILITY SERVICES IN COMMON ACCESSWAY TO BE IN RELEVANT DUCTS.
- 13. EXISTING SERVICES TO THE EXISTING DWELLING TO BE REDIRECTED IF REQUIRED TO THE RELEVANT BOUNDARIES.
- 14.EXISTING DRAINAGE TO BE LOCATED BEFORE ANY FOUNDATION WORK CARRIED OUT. IF REQUIRED, OR CRITICAL TO BRIDGING.
- 15. SURVEY DONE BY OTHERS, AA & CO INTERNATIONAL LTD DOES NOT TAKE ANY RESPONSIBILITIES OF LEVELS.
- 16. ALL DIMENSIONS AND MEASUREMENTS ARE IN METER, UNLESS NOTED OTHERWISE.
- 17. ALL MEASUREMENTS ARE APPROXIMATE ONLY AND ARE SUBJECT TO FINAL SURVEY



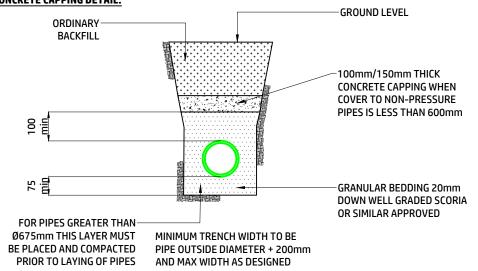

#### **BEDDING NOTES:**

- 1. FLEXIBLE PIPES INCLUDES PVC, GRP, PP AND PE
- 2. PLACEMENT OF EMBEDMENT, TRENCHFILL AND COMPACTION SHALL MEET THE REQUIREMENTS OF DRAWINGS AND SPECIFICATION
- 3. EXCAVATE OR COMPACT TRENCH FLOOR TO PROVIDE A FIRM BASE TO SUPPPORT BEDDING MATERIAL AN DMINIMISE PIPELINE SETTLEMENT. REPLACE EXCAVATED MATERIAL WITH SUITABLE GRANULAR MATERIAL FOR BEDDING
- 4. BEDDING MATERIALS SHALL BE GAP/SAP < 12
- 5. PROVIDE CONCRETE CAPPING WHERE PIPE COVER IS LESS THAN 600mm



#### BUN60397004

Approved Resource Consent Plan

07/09/2023

				A A & C O
				AA&CO. INTERNATIONAL
				Engineering + Design + Planning + Project Management
0	ISSUE FOR ENGINEERING CONSENT	FA	15/09/21	Unit 9, Level 2, 507 Great South Road, Otahuhu, Auckland 1062
Rev	Details	Chk	Date	PO Box 22075 Otahuhu, Auckland 1640


CLIENT:	ASHA DANG	PROJECT NAME:
ARCHITECT: R&S DESIGNS LTD		PROPOSED NEW BUILDING 235 BLOCKHOUSE BAY ROA
SURVEYOR:		AVONDALE AUCKLAND
CCTV:	-	HOCKERND


SHEET TITLE:  GENERAL SITE NOTES			SCALES A3:		EERING SENT
DESIGNED	T.A	SEP 2021	Job no.	SHEET NO.	REV.
DRAWN A.T SEP 2021		JAA0	C001	RO	
CHECKED	T.A	SEP 2021	JANO	2001	NO

#### **GENERAL NOTES:**

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- ALL WORK ON EXISTING STORMWATER AND SANITARY SEWER LINES TO CARRIED OUT BY A REGISTERED CONTRACTOR.
- ALL LEVELS ARE IN TERMS OF LANDS AND SURVEY DATUM. ALL CO-ORINATES ARE IN TERMS OF GEODETIC DATUM 2000.
- CERTIFIED ENGINEER/SURVEYOR TO ENSURE PIPES ARE LAID TO THE CORRECT GRADE AND DEPTH.
- ALL SANITARY SEWER LINES COULD BE uPVC AS/NZS 1260.PE-AS/NZS 5065 OR RRJRC - AS/NZS 4058 (WITH APPROPRIATE HYDROGEN SULPHIDE RESISTANCE ADDITIVES OR PLASTIC LINING). UNLESS OTHERWISE NOTED.
- ALL STORMWATER PIPES (OTHER THAN 150mm) ARE TO BE CLASS X REINFORCED CONCRETE RUBBER RING JOINTED, UNLESS SHOWN OTHERWISE
- ALL PROPOSED STORMWATER CONNECTIONS ARE TO BE 100mmØ UPVC OR OTHERWISE STATED. ALL SANITARY SEWER CONNECTIONS ARE TO BE 100mmØ uPVC. ALL CONNECTIONS ARE TO TERMINATE WITHIN 1.0m. UNLESS OTHERWISE NOTED AT THE NEW LOT BOUNDARY.
- 10.ALL MANHOLES ARE TO BE 1050mm FLANGE BASE WITH STANDARD LIDS AND COVERS BOLTED, UNLESS SHOWN OTHERWISE.
- 11. REFER TO STANDARD DRAWINGS FOR DETAILS.
- 12. HARDFILL BACKFILL TO BE GAP 65.
- 13.ALL PIPES ARE TO LAID IN APPROVED GRANULAR BEDDING. PIPES WITH A GRADE OF 10.0% OR MORE ARE TO BE LAID IN(5MPa) SCORIA CONCRETE BEDDING.
- 4.POSITION AND LEVEL (OR EXISTENCE) OF THE PUBLIC UTILITIES SERVICE, WATER MAIN AND OTHER SERVICE IS SUBJECT TO VERIFICATION ONSITE BY THE OWNER AND/OR THEIR CONTRACTOR.
- 5. THE CONTRACTOR TO LOCATE ALL THE UNDERGROUND SERVICES (POWER, TELECOM, GAS & WATER) ON SITE PRIOR TO CONSTRUCTION AND IF POSSIBLE LOCATED BY THE RELEVANT AUTHORITIES. THE LOCATION SHOWN IS JUST FOR INFORMATION ONLY.
- 16.THE CONTRACTOR TO APPLY FOR THE CAR & TRAFFIC MANAGEMENT PLANS FOR THE CONSTRUCTION OF THE SERVICE ON THE CARRIAGEWAY AND BEAM.
- 17.ALL THE UTILITY SERVICES IN COMMON ACCESSWAY TO BE IN RELEVANT DUCTS.
- 18.EXISTING SERVICES TO THE EXISTING DWELLING TO BE REDIRECTED IF REQUIRED TO THE RELEVANT BOUNDARIES. 19.EXISTING DRAINAGE TO BE LOCATED BEFORE ANY FOUNDATION
- WORK CARRIED OUT. IF REQUIRED, OR CRITICAL TO BRIDGING. 20. SURVEY DONE BY OTHERS, AA & CO INTERNATIONAL LTD DOES NOT
- TAKE ANY RESPONSIBILITIES OF LEVELS.
- 21.ALL DIMENSIONS AND MEASUREMENTS ARE IN METER, UNLESS NOTED OTHERWISE 22.ALL MEASUREMENTS ARE APPROXIMATE ONLY AND ARE SUBJECT
- TO FINAL SURVEY
- 23. ALL LEVELS ARE TO BE VERIFIED BY CONTRACTORS ONSITE.



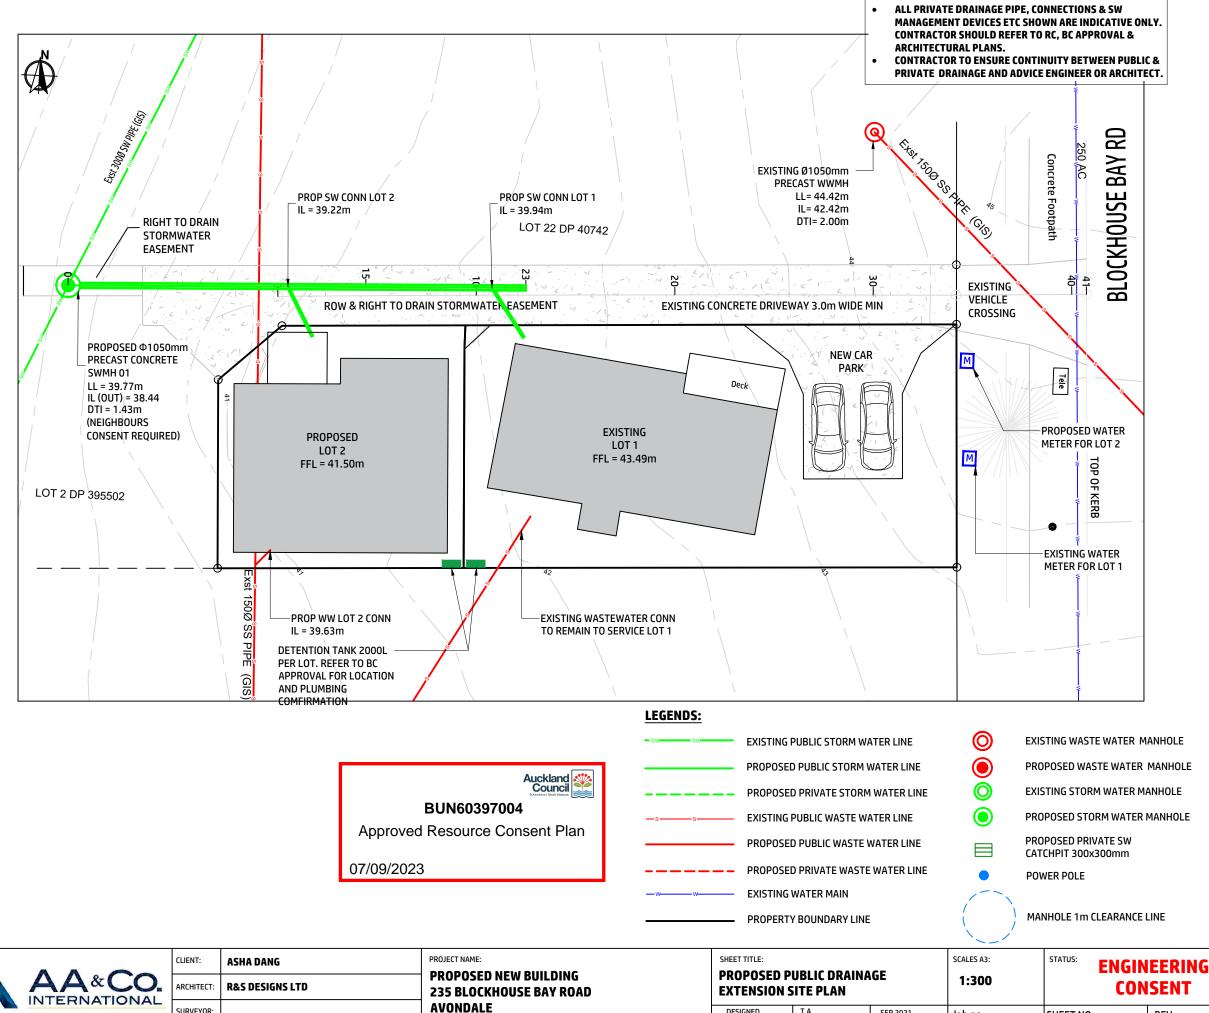

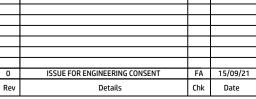


	CLIENT:	ASHA DANG	PROJECT NAME:
_	ARCHITECT:	R&S DESIGNS LTD	PROPOSED NEV 235 BLOCKHOU
nt	SURVEYOR:		AVONDALE AUCKLAND
	CCTV:	•	AUCKLAND

SHEET TITLE:		SCALES A3:	STATUS:	FNGIN	EERING	
PROPOSED PUBLIC DRAINAGE EXTENSION SITE PLAN			1:300			SENT
DESIGNED	T.A	SEP 2021	Job no.	SHEET NO.		REV.
DRAWN	A.T	SEP 2021	JAA0		C101	RO
CHECKED	T.A	SEP 2021	3/11/0			, no

#### **STORM WATER NOTES:**

- 1. ALL WORKMANSHIP AND MATERIALS SHALL COMPLY WITH AUCKLAND COUNCIL SPECIFICATION AND STANDARD DETAILS.
- 2. ALL WORK ON EXISTING STORMWATER AND SANITARY SEWER LINES TO CARRIED OUT BY A REGISTERED CONTRACTOR.
- 3. ALL LEVELS ARE IN TERMS OF LANDS AND SURVEY DATUM. ALL CO-ORINATES ARE IN TERMS OF GEODETIC DATUM 2000.
- 4. ALL PROPOSED STORMWATER CONNECTIONS ARE TO BE 100mmØ. ALL CONNECTIONS ARE TO TERMINATE WITHIN 1.0m, UNLESS OTHERWISE NOTED AT THE NEW LOT BOUNDARY.
- 5. ALL MANHOLES ARE TO BE FLANGE BASE 1050mm WITH STANDARD LIDS AND COVERS, UNLESS SHOWN OTHERWISE.
- 6. BEDDING TYPICALLY GAP 14 OR GAP 20. REFER TO CODE OF PRACTICE FOR WORKING IN THE ROAD BY AUCKLAND TRANSPORT.
- 7. REFER TO STANDARD DRAWINGS FOR DETAILS.
- 8. HARDFILL BACKFILL TO BE GAP 65.
- ALL PIPES ARE TO LAID IN APPROVED GRANULAR BEDDING. PIPES WITH A GRADE OF 10.0% OR MORE ARE TO BE LAID IN (5MPa) SCORIA CONCRETE BEDDING.
- 10. THE CONTRACTOR TO LOCATE ALL THE UNDERGROUND SERVICES (POWER, TELECOM, GAS & WATER) ON SITE PRIOR TO CONSTRUCTION AND IF POSSIBLE LOCATED BY THE RELEVANT AUTHORITIES. THE LOCATION SHOWN IS JUST FOR INFORMATION ONLY.
- 11.ALL THE UTILITY SERVICES IN COMMON ACCESSWAY TO BE IN RELEVANT DUCTS.
- 12. THE CONTRACTOR TO APPLY FOR THE CAR & TRAFFIC MANAGEMENT PLANS FOR THE CONSTRUCTION OF THE SERVICE ON THE CARRIAGEWAY AND BERM.
- 13. EXISTING SERVICES TO THE EXISTING DWELLING TO BE REDIRECTED IF REQUIRED TO THE RELEVANT BOUNDARIES.
- 14. EXISTING DRAINAGE TO BE LOCATED BEFORE ANY FOUNDATION WORK CARRIED OUT. IF REQUIRED, OR CRITICAL TO BRIDGING.
- 15. SURVEY DONE BY OTHERS, AA&CO INTERNATIONAL LTD DOES NOT TAKE ANY RESPONSIBILITIES OF LEVELS.
- 16. ALL DIMENSIONS AND MEASUREMENTS ARE IN METER, UNLESS NOTED OTHERWISE.
- 17. ALL MEASUREMENTS ARE APPROXIMATE ONLY AND ARE SUBJECT TO FINAL SURVEY.

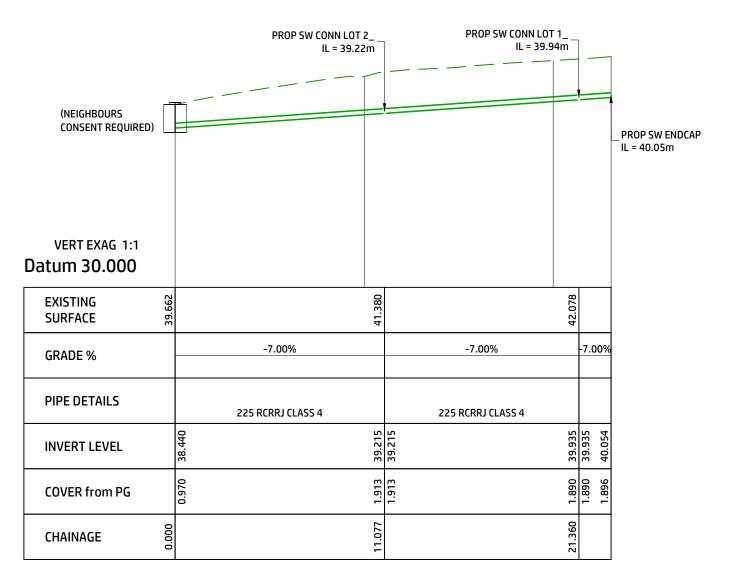

PROPOSED SW NETWORK LONG SECTION

Auckland Council

BUN60397004

Approved Resource Consent Plan

07/09/2023

				AA&CO.
				INTERNATIONAL
				Engineering + Design + Planning + Project Management
0	ISSUE FOR ENGINEERING CONSENT	FA	15/09/21	Unit 9, Level 2, 507 Great South Road, Otahuhu, Auckland 1062
Rev	Details	Chk	Date	PO Box 22075 Otahuhu, Auckland 1640 Mobile: +64 21 686 075 / +64 22 694 7656   Email: admin@aacointernation.com


CLIENT:	ASHA DANG	PROJECT NAME:
ARCHITECT:	R&S DESIGNS LTD	PROPOSED NEW BUILDING 235 BLOCKHOUSE BAY ROAD
SURVEYOR:		AVONDALE AUCKLAND
CCTV:	-	AUCKLAND

SHEET TITLE: PROPOSED STORM WATER PUBLIC LINE LONG SECTION DETAIL			SCALES A3:  AS INDICATED	STATUS:		EERIN SENT	G
DESIGNED	T.A	SEP 2021	Job no.	SHEET NO.		REV.	
DRAWN	A.T	SEP 2021	JAA0		C102	RO	
CHECKED	T.A	SEP 2021	1 JAAU		C.O.	NO	

#### **GENERAL NOTES:**

#### 1.1. PRIOR TO CONSTRUCTION:

- 1.2. CONTRACTOR TO CONFIRM LOCATION OF ALL SERVICES ON SITE PRIOR TO CONSTRUCTION. NOTIFY AND DISCUSS ANY DISCREPANCIES WITH DESIGN AND/OR SITE ENGINEER.
- 1.3. THE CONTRACTOR SHALL CHECK ALL DIMENSIONS ON SITE AND CONFIRM ALL DETAILS ARE CONSISTENT BETWEEN ARCHITECTURAL AND ENGINEERING DRAWINGS. DISCREPANCIES ARE TO BE NOTIFIED AND DISCUSSED WITH ARCHITECT AND DESIGN ENGINEER IMMEDIATELY, AND PRIOR TO COMMENCEMENT OF WORK.
- 1.4. THE CONTRACTOR SHALL SUBMIT CONSTRUCTION METHODOLOGY TO ENGINEER FOR REVIEW, DISCUSSION AND APPROVAL
- ALL WORKMANSHIP AND MATERIALS SHALL COMPLY WITH WATERCARE AND AUCKLAND COUNCIL SPECIFICATION AND STANDARD DETAILS
- ALL MEASUREMENTS AND DIMENSIONS ARE IN METER, UNLESS NOTED OTHERWISE.
- ALL WORK ON EXISTING STORMWATER AND SANITARY SEWER LINES TO CARRIED OUT BY A REGISTERED CONTRACTOR.
- ALL LEVELS ARE IN TERMS OF LANDS AND SURVEY DATUM. ALL CO-ORINATES ARE IN TERMS OF GEODETIC DATUM 2000.
- CERTIFIED ENGINEER/SURVEYOR TO ENSURE PIPES ARE LAID TO THE CORRECT GRADE AND DEPTH.
- ALL SANITARY SEWER LINES COULD BE uPVC AS/NZS 1260.PE-AS/NZS 5065 OR RRJRC - AS/NZS 4058 (WITH APPROPRIATE HYDROGEN SULPHIDE RESISTANCE ADDITIVES OR PLASTIC LINING). UNLESS OTHERWISE NOTED.
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- ALL PROPOSED STORMWATER CONNECTIONS ARE TO BE 100mmØ UPVC OR OTHERWISE STATED. ALL SANITARY SEWER CONNECTIONS ARE TO BE 100mmØ uPVC. ALL CONNECTIONS ARE TO TERMINATE WITHIN 1.0m. UNLESS OTHERWISE NOTED AT THE NEW LOT BOUNDARY.
- 10.ALL MANHOLES ARE TO BE 1050mm FLANGE BASE WITH STANDARD LIDS AND COVERS BOLTED, UNLESS SHOWN OTHERWISE.
- 11. REFER TO STANDARD DRAWINGS FOR DETAILS.
- 12. HARDFILL BACKFILL TO BE GAP 65.
- 13.ALL PIPES ARE TO LAID IN APPROVED GRANULAR BEDDING. PIPES WITH A GRADE OF 10.0% OR MORE ARE TO BE LAID IN(5MPa) SCORIA CONCRETE BEDDING.
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- 5. THE CONTRACTOR TO LOCATE ALL THE UNDERGROUND SERVICES (POWER, TELECOM, GAS & WATER) ON SITE PRIOR TO CONSTRUCTION AND IF POSSIBLE LOCATED BY THE RELEVANT AUTHORITIES. THE LOCATION SHOWN IS JUST FOR INFORMATION ONLY.
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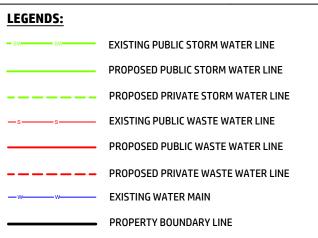


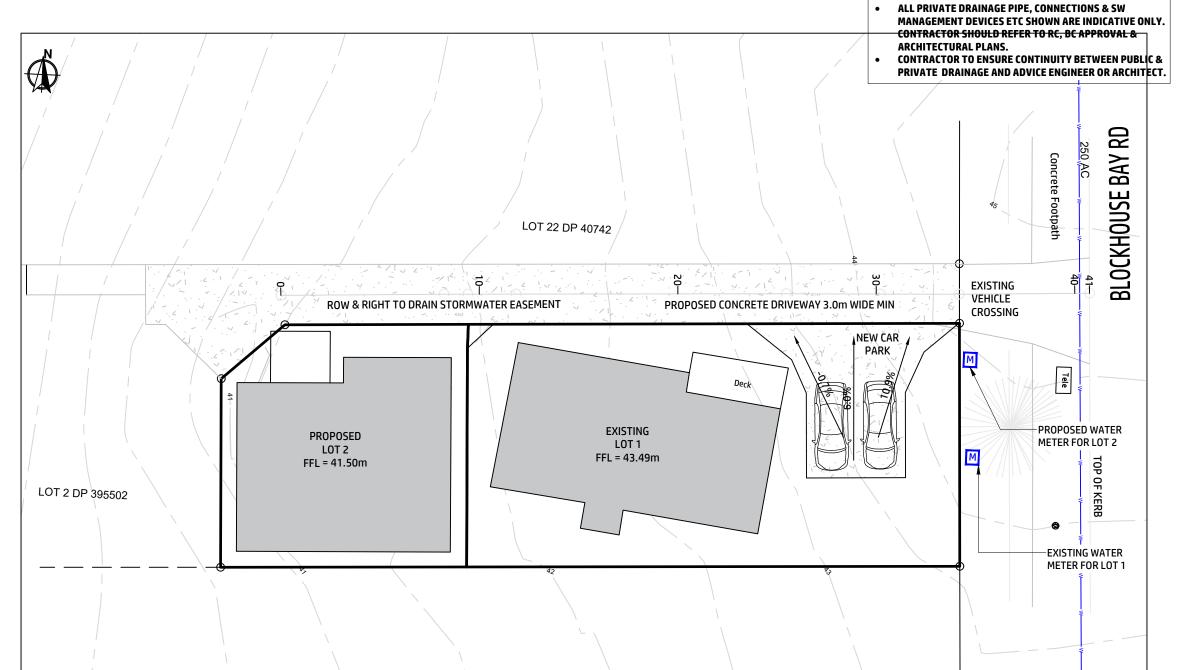**PROPOSED NEW BUILDING** 

**AVONDALE** 

**AUCKLAND** 

**235 BLOCKHOUSE BAY ROAD** 



**EXISTING WASTE WATER MANHOLE** PROPOSED WASTE WATER MANHOLE **EXISTING STORM WATER MANHOLE** 

PROPOSED STORM WATER MANHOLE

PROPOSED PRIVATE SW CATCHPIT 300x300mm

**POWER POLE** 

MANHOLE 1m CLEARANCE LINE

REV.

R2

2	ISSUE FOR ENGINEERING CONSENT	DK	16/08/23
1	ISSUE FOR ENGINEERING CONSENT	DK	18/07/23
0	ISSUE FOR ENGINEERING CONSENT	FA	15/09/21
Rev	Details	Chk	Date

Engineering + Design + Planning + Project Manageme Unit 9, Level 2, 507 Great South Road, Otahuhu, Auckland 1062 PO Box 22075 Otahuhu, Auckland 1640 Mobile: +64 21 686 075 / +64 22 694 7656 | Email: admin@aacointernation.com

	CLIENT:	ASHA DANG
_	ARCHITECT:	R&S DESIGNS LTD
nt	SURVEYOR:	
	CCTV:	•
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SHEET TITLE: SCALES A3: **ENGINEERING DRIVEWAY SITE PLAN** 1:300 CONSENT DESIGNED SEP 2021 Job no. SHEET NO. DRAWN SEP 2021 **D001** JAA0 CHECKED SEP 2021

#### **DRIVEWAY NOTES:**

- 1. ALL PRIVATE DRIVEWAY WORK TO COMPLY WITH AUCKLAND TRANSPORT STANDARDS.
- 2. ALL WORK ON EXISTING STORMWATER AND SANITARY SEWER LINES TO BE CARRIED OUT BY A REGISTERED CONTRACTOR.
- 3. TOPOGRAPHIC DATA ARE OBTAINED FROM SURVEYOR.
- 4. ALL LEVELS ARE IN TERMS OF LANDS AND SURVEY DATUM. ALL CO-ORINATES ARE IN TERMS OF GEODETIC DATUM 2000.
- 5. REFER TO STANDARD DRAWINGS FOR DETAILS.
- 6. SUBGRADE TO HAVE A MINIMUM CBR OF 7 AS PER AUCKLAND TRANSPORT ENGINEERING STANDARDS
- 7. BEDDING TYPICALLY 50mm MINNIMUM COMPACTED GAP 20 AS PER AUCKLAND TRANSPORT ENGINEERING STANDARDS
- 8. BASECOURSE TO BE 150mm THICK CONCRETE AS PER AUCKLAND TRANSPORT ENGINEERING STANDARDS
- ALL CONCRETE TO BE 20MPa AND CONTRUCTED IN ACCORDANCE WITH NZS 3109 WITH A BROOM FINISH. SAWCUT EXPANSION JOINTS AT 4m CENTRES.
- 10. THE CONTRACTOR TO LOCATE ALL THE UNDERGROUND SERVICES (POWER, TELECOM, GAS & WATER) ON SITE PRIOR TO CONSTRUCTION AND IF POSSIBLE LOCATED BY THE RELEVANT AUTHORITIES. THE LOCATION SHOWN IS JUST FOR INFORMATION ONLY.
- 11.THE CONTRACTOR TO APPLY FOR THE CAR & TRAFFIC MANAGEMENT PLANS FOR THE CONSTRUCTION OF THE SERVICE ON THE CARRIAGEWAY AND BERM.
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- 14. EXISTING DRAINAGE TO BE LOCATED BEFORE ANY FOUNDATION WORK CARRIED OUT. IF REQUIRED, OR CRITICAL TO BRIDGING.
- 15. SURVEY DONE BY OTHERS, AA & CO INTERNATIONAL LTD DOES NOT TAKE ANY RESPONSIBILITIES OF LEVELS.
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- 17. ALL MEASUREMENTS ARE APPROXIMATE ONLY AND ARE SUBJECT TO FINAL SURVEY




#### BUN60397004

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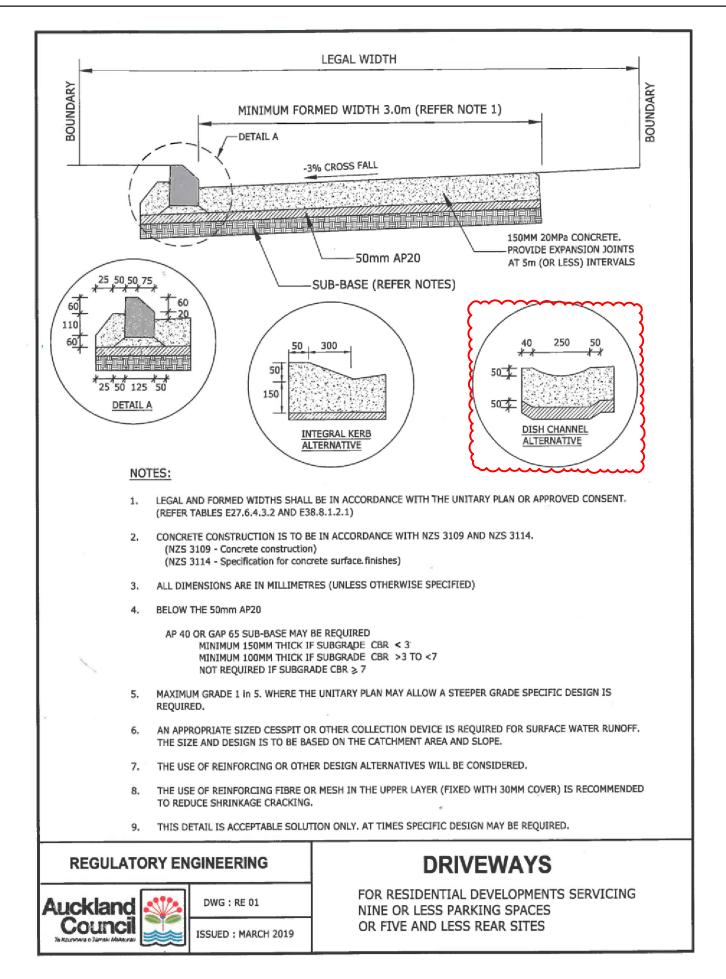
07/09/2023

- ALL PRIVATE DRAINAGE PIPE, CONNECTIONS & SW MANAGEMENT DEVICES ETC SHOWN ARE INDICATIVE ONLY. CONTRACTOR SHOULD REFER TO RC, BC APPROVAL & ARCHITECTURAL PLANS.
- CONTRACTOR TO ENSURE CONTINUITY BETWEEN PUBLIC &
   PRIVATE DRAINAGE AND ADVICE ENGINEER OR ARCHITECT.
- DRIVEWAY TO BE 150mm 20MPa CONCRETE, PROVIDE EXPANSION JOINTS AT 5m (OR LESS) INTERVALS UNLESS STATED OTHERWISE

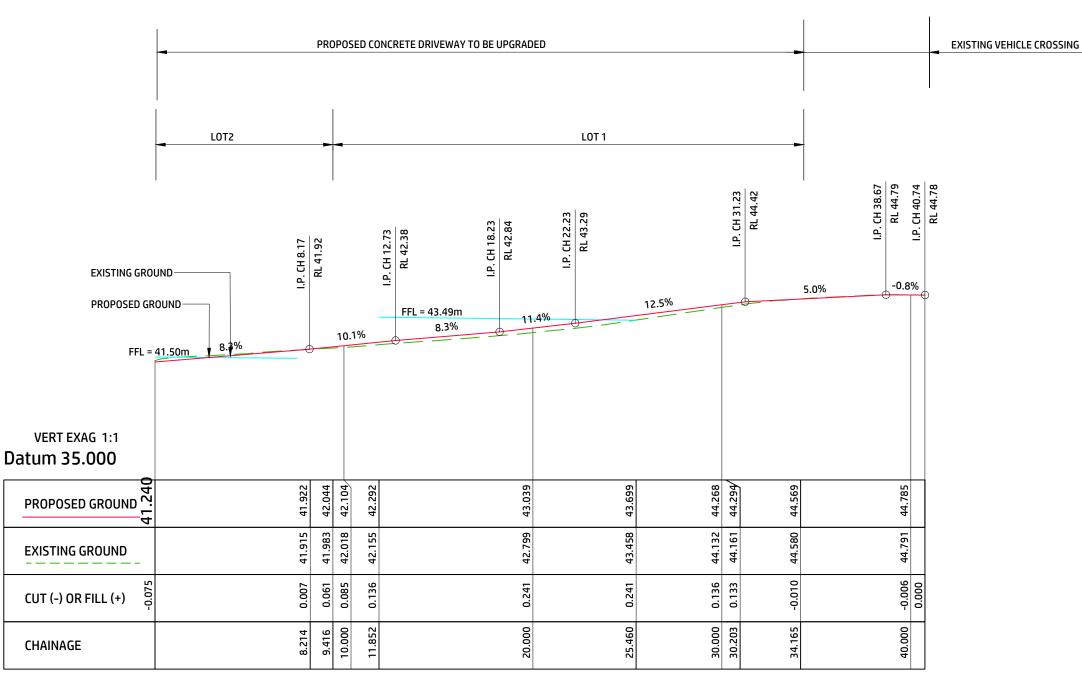

#### **EXISTING CONCRETE DRIVEAWAY LONG SECTION**

				<u> </u>	A A O =	CLIENT:	ASHA DANG	PROJECT NAME:	SHEET TITLE:	OMMON ACC	ECC WAY LONG		STATUS: ENGIN	IEERING
3	ISSUE FOR ENGINEERING CONSENT	DK 28	3/08/23		AA&CO.	ARCHITECT:	R&S DESIGNS LTD	PROPOSED NEW BUILDING 235 BLOCKHOUSE BAY ROAD	SECTION	UMMUN ACCI	ESS WAY LONG	AS INDICATED	CON	ISENT
2	ISSUE FOR ENGINEERING CONSENT ISSUE FOR ENGINEERING CONSENT	DK 18	3/08/23 3/07/23			SURVEYOR:		AVONDALE AUCKLAND	DESIGNED	T.A	SEP 2021	Job no.	SHEET NO.	REV.
0	ISSUE FOR ENGINEERING CONSENT	FA 1:	5/09/21		7 Great South Road, Otahuhu, Auckland 1062			AUCKLAND	DRAWN	A.T	SEP 2021	JAA0	D002	DS
Rev	Details	Chk	Date		x 22075 Otahuhu, Auckland 1640 +64 22 694 7656   Email: admin@aacointernation.com	CCTV:	-		CHECKED	T.A	SEP 2021	JAAO	D002	, No



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PROJECT NAME: PROPOSED NEW BUILDING **235 BLOCKHOUSE BAY ROAD AVONDALE AUCKLAND** 

SHEET TITLE: RESIDENTIAL DRIVEWAY DETAIL FROM AUCKLAND COUNCIL			SCALES A3:	STATUS:	EERING SENT	
DESIGNED	T.A	SEP 2021	Job no.	SHEET NO.		REV.
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Auckland Council

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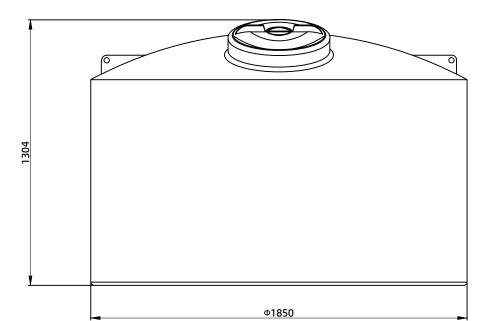
Approved Resource Consent Plan


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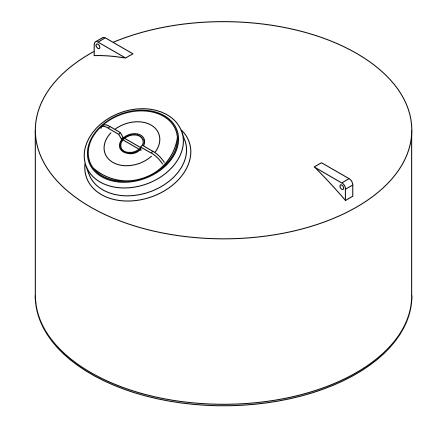
Auckland Council

Approved Resource Consent Plan

07/09/2023





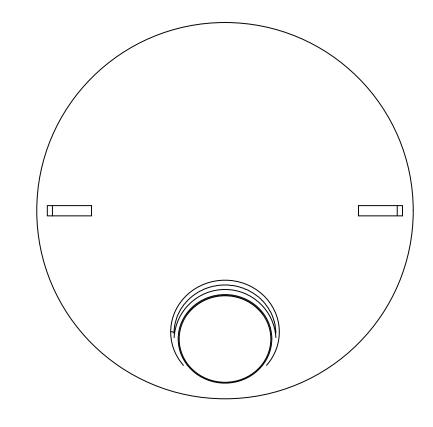

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				Engineering + Design + Planning + Project Managem
0	ISSUE FOR ENGINEERING CONSENT	FA	15/09/21	Unit 9, Level 2, 507 Great South Road, Otahuhu, Auckland 1062
Rev	Details	Chk	Date	PO Box 22075 Otahuhu, Auckland 1640 Mobile: +64 21 686 075 / +64 22 694 7656   Email: admin@aacointernation.com

	CLIENT:	ASHA DANG
_	ARCHITECT:	R&S DESIGNS LTD
nt	SURVEYOR:	
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PROJECT NAME:
PROPOSED NEW BUILDING
235 BLOCKHOUSE BAY ROAD
AVONDALE
AUCKLAND

SHEET TITLE: PROPOSED ABOVE GROUN DETENTION TANK	SCALES A3:	STATUS:	ENGIN CON	EERIN SENT	IG	
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